

Appendix C

Drawings, Figures and Photos of Ancillary Facilities and Equipment

Examples of Hand Hole Junction Box Installations

Grand Teton Nation Park Headquarters (Moose, Wy.) Proposed Hut Site

Proposed Hut Location at DTE Site on Togwotee Pass (Exhibit A & B)

Photographs of Proposed DTE Hut Site on Togwotee Pass

Typical Drawings of a Telecommunications Hut (Thermobond Building - 9 Sheets)

Typical Construction Equipment on Site During Installation.

Typical exterior mounted optical network terminal (ONT) schematic.

Examples of Hand Hole Junction Box Installations



Photo 1: Typical hand hole connection.



Photo 2: Connection platform to go inside hand hole.



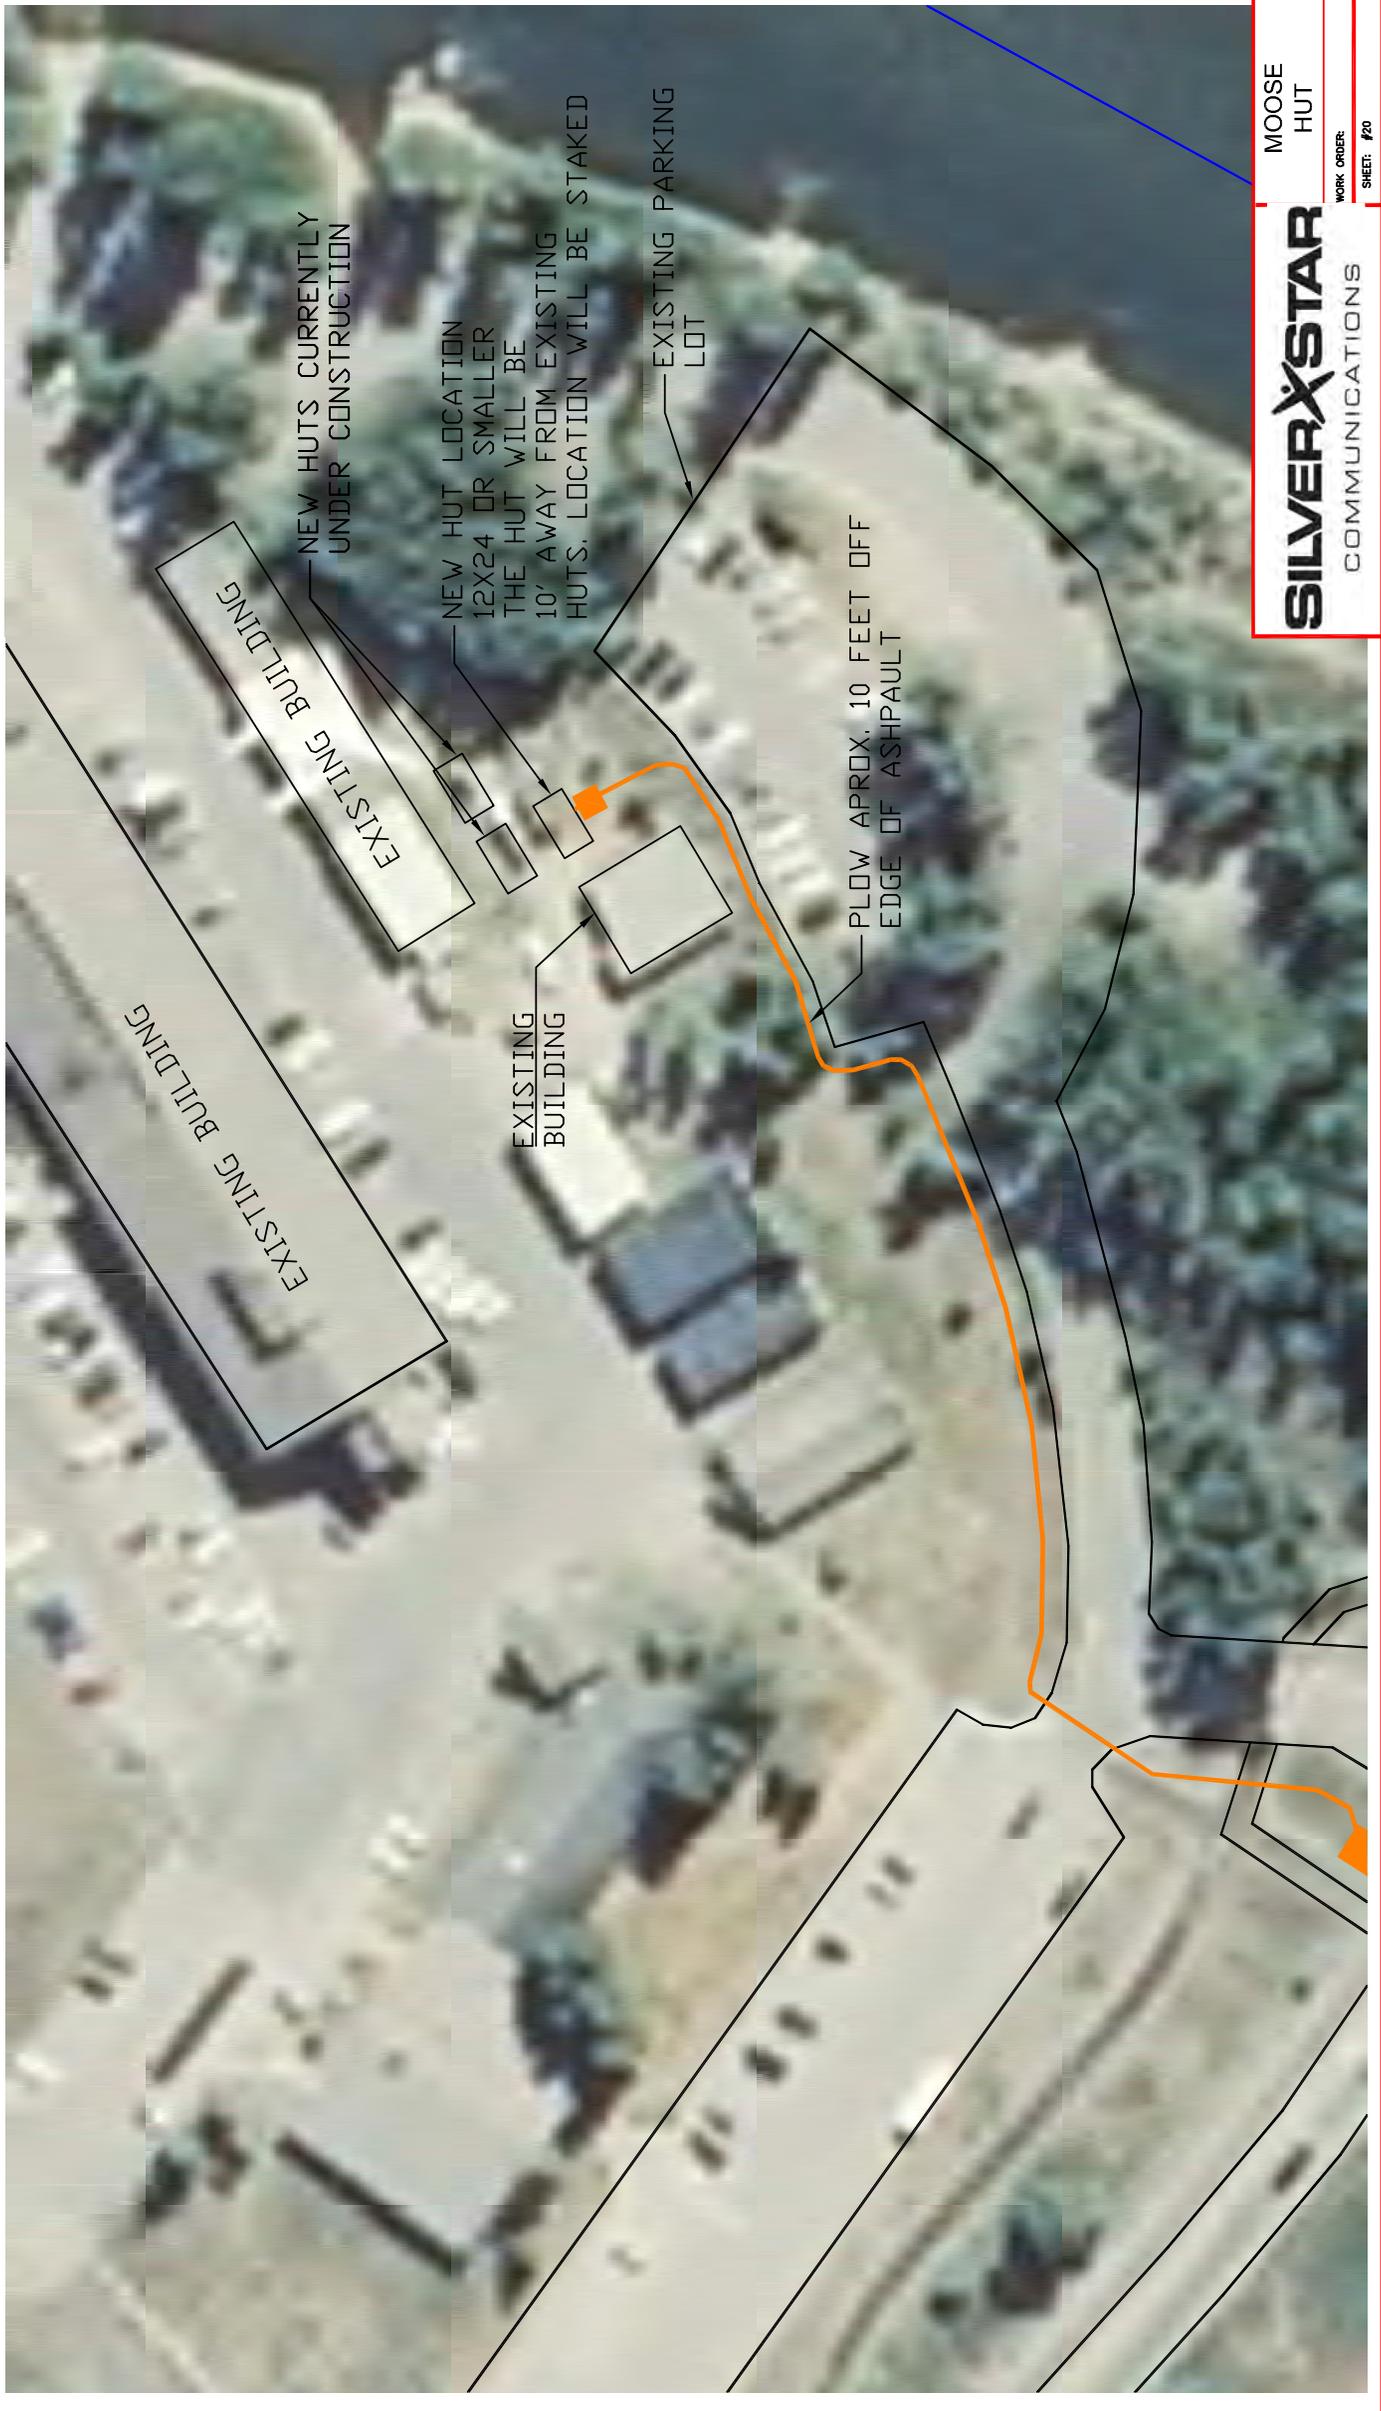
Photo 3: Typical hand hole installed in lawn.



Photo 4: Typical hand hole installation in residential area.



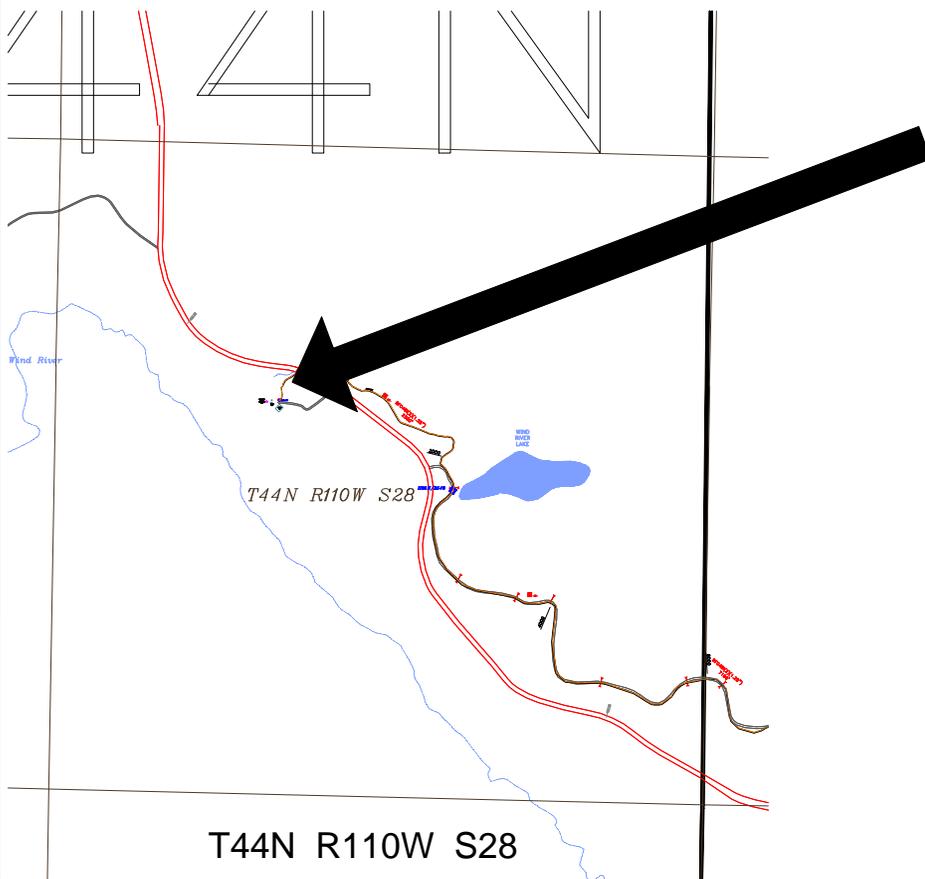
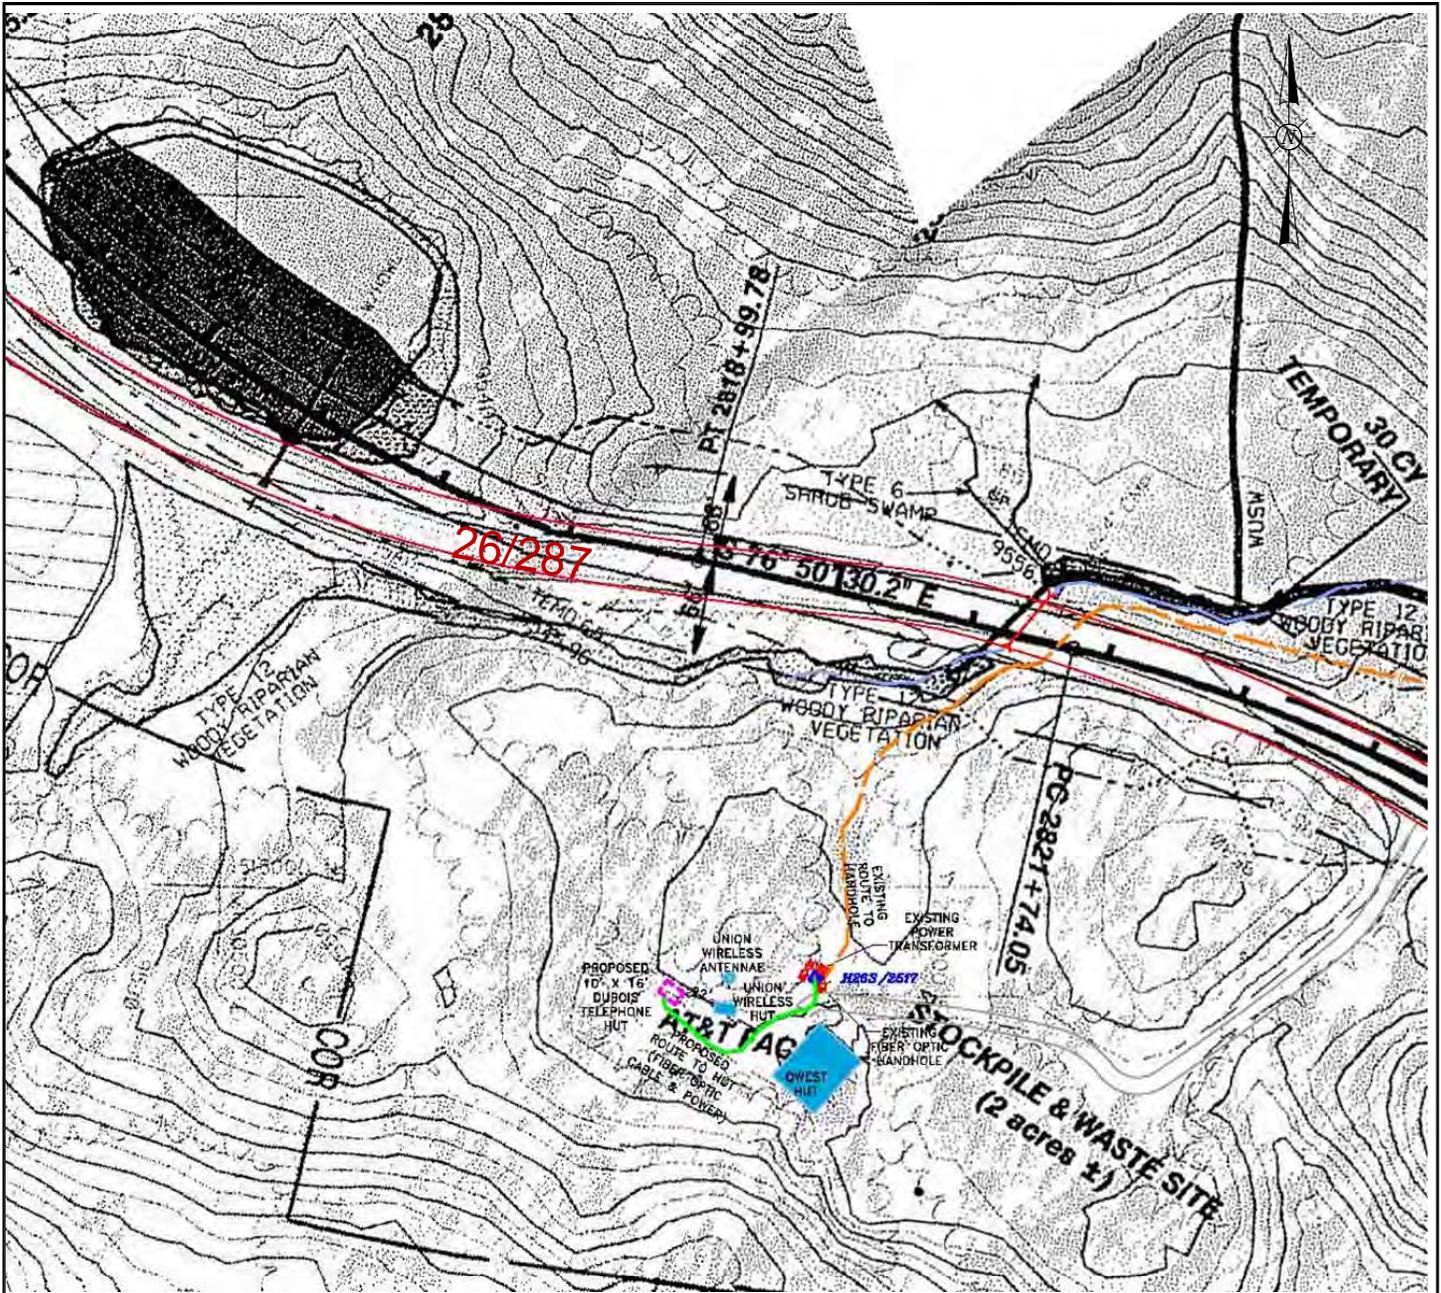
Photo 5: Typical hand hole installation along highway.



MOOSE HUT

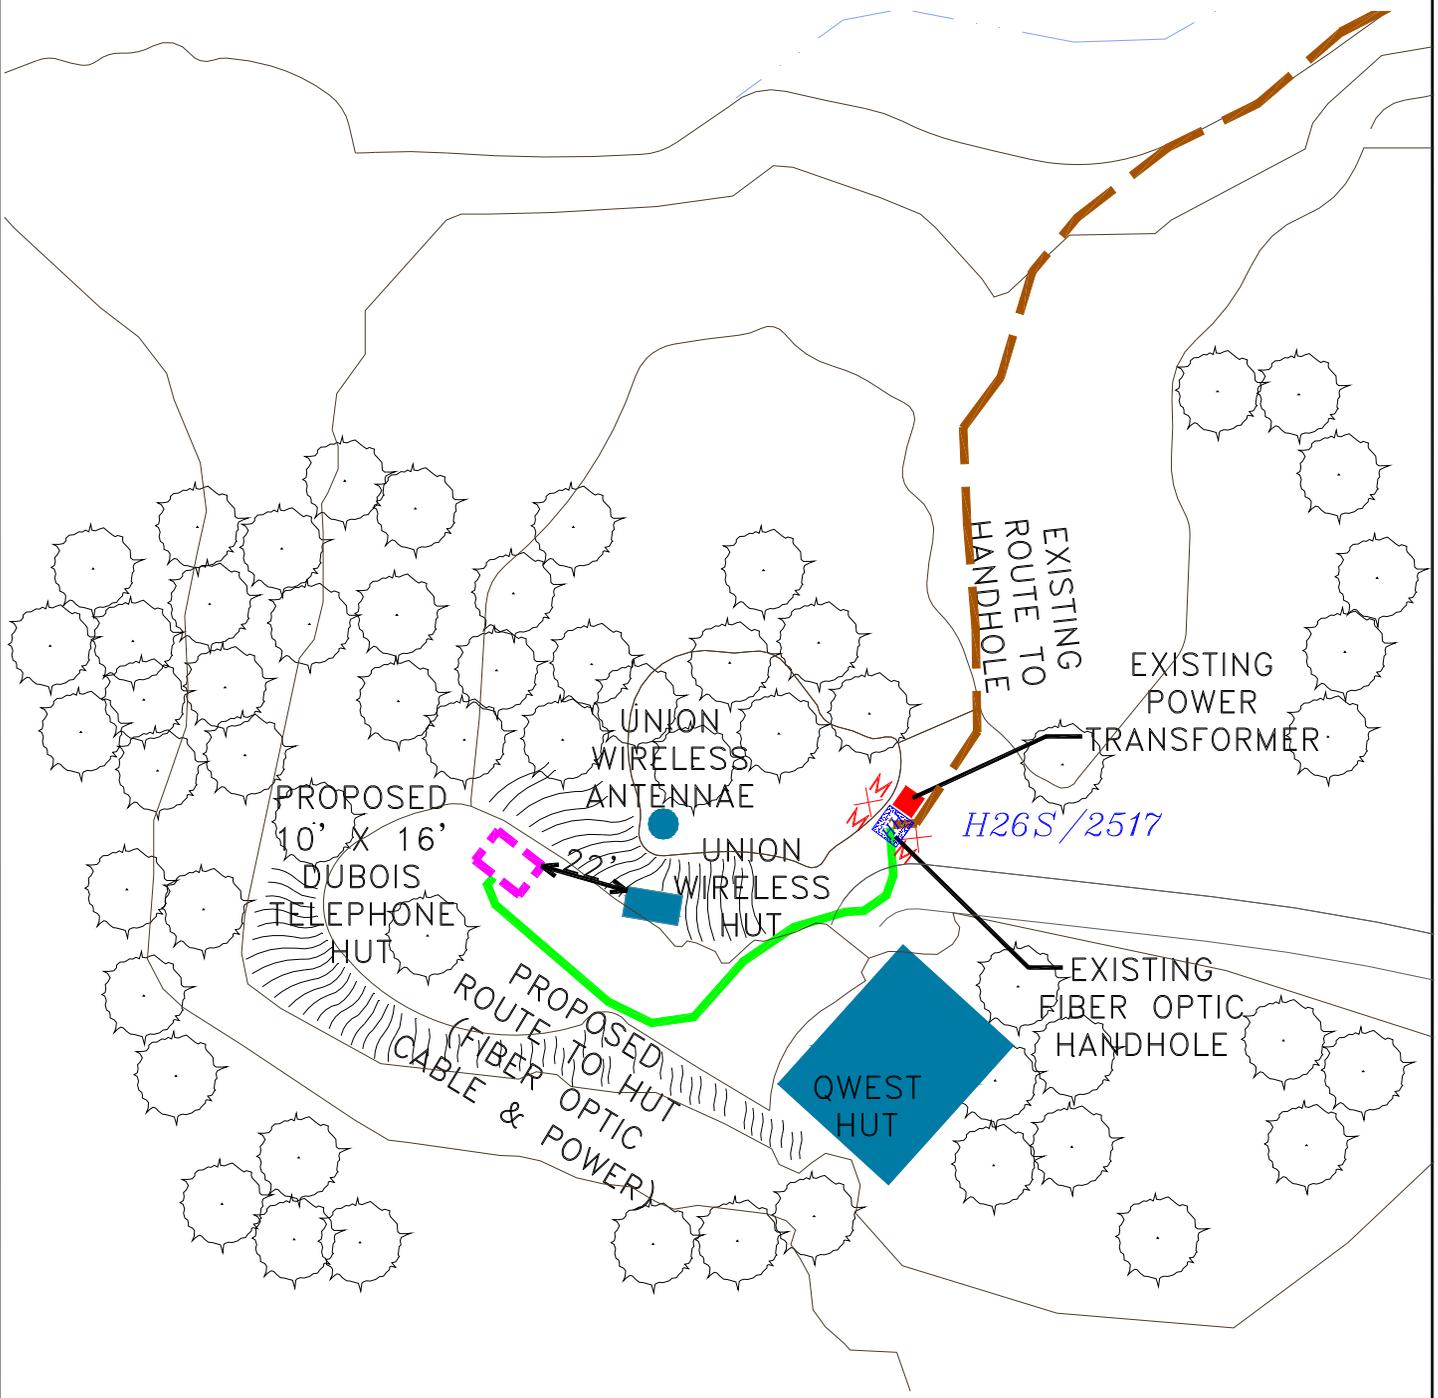
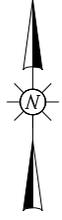
SILVERSTAR
COMMUNICATIONS

WORK ORDER:
SHEET: #20



HUT SITE – EXHIBIT A
 T44N R110W
 SEC 28
 PAGE 1 OF 2

11-12-10



HUT SITE – EXHIBIT B
T44N R110W
SEC 28
PAGE 2 OF 2

11-12--10



Proposed Hut Location at DTE Site on Togwotee Pass



Photo 1. Orange flags represent location of proposed DTE hut at the Togwotee Pass Site. (Photos 1 thru 3)



Photo 2.



Photo 3.

BUILDING EXTERIOR

- BUFF
- OZARK
- GREY
- OTHER HARDIE PLANK SIDING

PROJECT
INTERSTATE TELCOM COOP

JOB NO.

1004-45

SITE NAME

BROOKINGS, SD.

SIZE

12' W O.D. X 24' L O.D. X 9' H I.D.

DRAWING TITLE

DRAWING NUMBER

DRAWING INDEX_____	AGB8477	PAGE 1 OF 9
REVISION LOG_____	AGB8477	PAGE 2 OF 9
INTERIOR LAYOUTS_____	AGB8477	PAGE 3 OF 9
INTERIOR LAYOUTS_____	AGB8477	PAGE 4 OF 9
ELEVATION VIEWS_____	AGB8477	PAGE 5 OF 9
GENERAL NOTES_____	AGB8477	PAGE 6 OF 9
BUILDING CONSTRUCTION DETAILS_____	AGB8477	PAGE 7 OF 9
BUILDING CONSTRUCTION DETAILS_____	AGB8477	PAGE 8 OF 9
BUILDING CONSTRUCTION DETAILS_____	AGB8477	PAGE 9 OF 9
BUILDING SKID ASSEMBLY_____	15R1224	PAGE 1 OF 1
BUILDING FOUNDATION ASSEMBLY_____	S15R1224	PAGE 1 OF 1

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Scale: NONE

Title:

DRAWING INDEX

Date: 7/21/10

PROJECT NUMBER:

Drawing Number:
AGB8477

Drawn By: DUO

Approved By:

COMPUTER AIDED DRAWING AGB8477F

PAGE 1 OF 9

GENERAL NOTES

1. HARDIPLANK SIDING PAINTED W/ DIAMOND VOGAL HILLSBORO TAN IN COLOR.
2. METAL 26 GAUGE ROOF BURNISHED SLATE W/ BROWN FACIA AND WHITE SOFFIT.
3. DOUBLE FLOOR JOIST 16" OC.
4. ROOF TRUSS TO HAVE 4/12 PITCH AND BE 16" OC FASTENED WITH HURRICANE CLIPS.
5. SHIP MASTER GROUND BAR LOOSE IN THE BUILDING. DO NOT ATTACH TO THE WALL.
6. INSTALL NATURAL GAS GENERATOR IN THE AURORA BUILDING AND THE LP VAPOR GENERATOR IN THE BROOKINGS NORTH BUILDING.

ELECTRICAL NOTES

1. ALL WIRING SHALL BE IN ACCORDANCE WITH THE NATIONAL ELECTRIC CODE (NFPA700, NEC-2008).
2. ALL ELECTRICAL MATERIALS SHALL BE U.L. LISTED AND CLASSIFIED AS SUITABLE FOR THE PURPOSE SPECIFIED.
3. ALL WIRING SHALL BE SURFACE MOUNTED IN A RACEWAY OR EMT CONDUIT USING APPROVED CONNECTORS, COUPLINGS, AND CLAMPS, ALL CONDUIT SHALL BE ANCHORED IN PLACE AT APPROXIMATELY EVERY 4 FT.
4. ALL WIRING SHALL BE A SOLID CONDUCTOR, THHN OR THWN COPPER, NO SMALLER THAN A #12.
5. ALL WIRE RUNS SHALL BE CONTINUOUS.
6. LOW VOLTAGE WIRE MAY BE STRANDED.
7. ALL WIRING SHALL BE TESTED AND INSPECTED PRIOR TO SHIPMENT.
8. GREEN GROUND CONDUCTORS SHALL BE RUN TO ALL OF THE BUILDINGS A/C POWERED DEVICES. CONDUIT SHALL NOT BE USED AS THE SOLE SOURCE OF GROUND.
9. ALL ALARM DEVICES WIRING SHALL BE RUN IN ITS OWN CONDUIT TO THE ALARM CABINET.
10. GROUNDING MUST MEET R-56 GROUNDING REQUIREMENTS.

PROJECT
INTERSTATE TELCOM COOP
JOB NO.
1004-45
SITE NAME
BROOKINGS, SD

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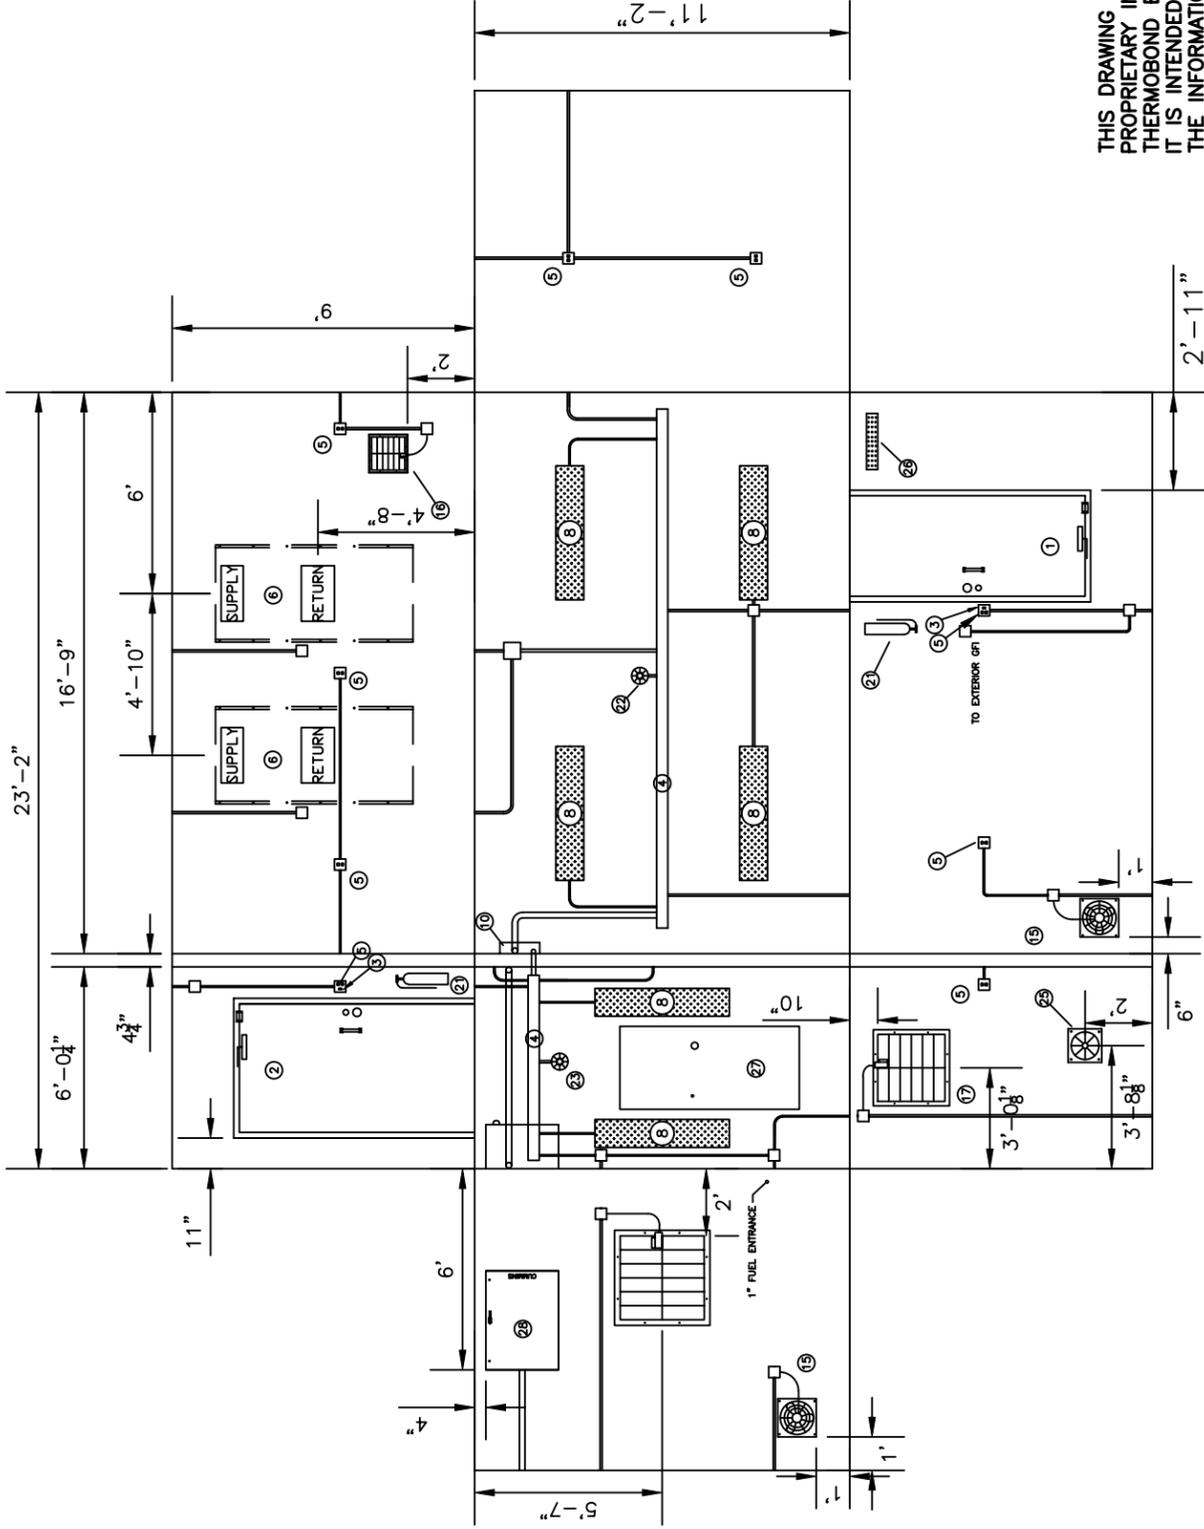


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Scale:	NONE	Title:	REVISION LOG
Date:	7/21/10		GENERAL NOTES
Drawn By:	DJO	PROJECT NUMBER:	
Approved By:		Drawing Number:	AGB8477

NOTES:

1. ALL DIMENSIONS ARE INSIDE DIMENSIONS.
2. ALL CONDUIT RUNS ARE APPROXIMATE AND MAY NOT REFLECT RUNS IN ACTUAL BUILDING.
3. INSTALL THE NATURAL GAS GEN SET IN THE AURORA BUILDING AND THE LP VAPOR GEN SET IN THE BROOKINGS NORTH BUILDING.



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PROJECT
 INTERSTATE TELCOM COOP
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 1004-45
 SITE NAME
 BROOKINGS, SD



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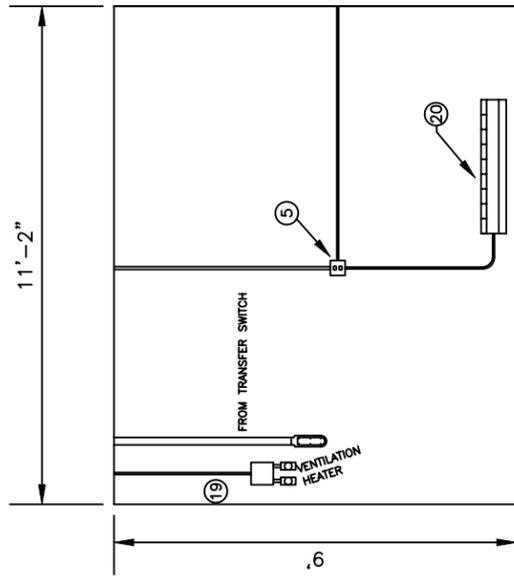
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Date: 7/21/10	12'W. X 24'L. X 9'H. BLDG.
Drawn By: DUO	PROJECT NUMBER: 8/2/10
Approved By:	Drawing Number: AGB8477
	COMPUTER AIDED DRAWING AGB8477

NO.	QTY.	DESCRIPTION
28.	1	ONAN 225 AMP, AUTOMATIC TRANSFER SWITCH #OTEC225
27.	1	ONAN 20 KW GENERATOR 20 GGMA, NATURAL GAS INSTALLED IN THE AURORA BUILDING AND LP VAPOR INSTALLED IN THE BROOKINGS NORTH BUILDING.
26.	1	20" MASTER GROUND BAR # GT114420, (SHIPPED LOOSE)
25.	1	2 1/2" GENERATOR EXHAUST THIMBLE
24.	1	ALARM CABINET W/ TERMINAL STRIP & FOLLOWING ALARMS: HIGH-LOW TEMP, HUMIDITY, OPEN DOOR (2), SMOKE, HEAT (GENERATOR ROOM) & POWER FAIL
23.	1	200 DEGREE HEAT DETECTOR. 3AU41 W/ 3KN55 RELAY
22.	1	SMOKE DETECTOR. 3KN56 W/ 3KN55 RELAY
21.	2	10# ABC FIRE EXTINGUISHER #4T889
20.	1	36" BASEBOARD HEATER, # 3UG83,
19.	3	2E206 THERMOSTAT, (VENTILATION, BASEBOARD HEATER)
18.	1	30" INTAKE DAMPER W/ HOOD #3C234
17.	1	24" EXHAUST DAMPER W/ HOOD #3C315
16.	1	12" INTAKE DAMPER W/ WEATHERPROOF HOOD #4C556 W/ #2C831 MOTOR
15.	2	12" EXHAUST FANS #1HLA2 W/ WEATHERPROOF HOOD
14.	2	100 W EXTERIOR LIGHT W/ VANDAL PROOF POLYCARBONATE LENS W/PE CELL #3GB98 W/ # 1NC57 BACK BOX
13.	1	ATLANTIC SCIENTIFIC SURGE ARRESTER # 11214
12.	1	200 AMP METER SOCKET, MILBANK #U4801-XL
11.	1	200 AMP MAIN DISCONNECT,NEMA 3R, SQD # Q022200NRB W/ QBL22200 BREAKER
10.	1	120/240V., 200A. 1 PHASE DISTRIBUTION PANEL W/ 200A. MAIN BREAKER AND 40 POSITIONS, SQD#Q0140M200
9.	2	EXTERIOR GFI RECEPTACLE
8.	6	4', 2 BULB FLOURESCENT LIGHT FIXTURE
7.	1	MC3000A MASTER CONTROLLER
6.	2	WALL MOUNT AIR CONDITIONER, BARD 2 TON W/5KW HEAT #WA242-A05PXXXXJ
5.	10	110V. DUPLEX RECEPTACLES
4.	A/R	4" SQUARE RACEWAY
3.	2	LIGHT SWITCH SPEC. GRADE
2.	1	4' X 7' STEEL INSULATED DOOR AND FRAME W/BAKED ON ENAMEL PAINT (PLYCO SERIES 88) W/S.S. BALL BEARING HINGES W/NON REMOVEABLE PINS, SCHLAGE PASSAGE & MEDICO DEADBOLT, PICKPLATE & HYDRAULIC CLOSURE. BOTH DOOR LOCKS KEYED ALIKE .
1.	1	3'X7' STEEL INSULATED DOOR AND FRAME W/BAKED ON ENAMEL PAINT (PLYCO SERIES 88) W/S.S. BALL BEARING HINGES W/NON REMOVEABLE PINS, SCHLAGE PASSAGE & MEDICO DEADBOLT, PICKPLATE & HYDRAULIC CLOSURE. BOTH DOOR LOCKS KEYED ALIKE .

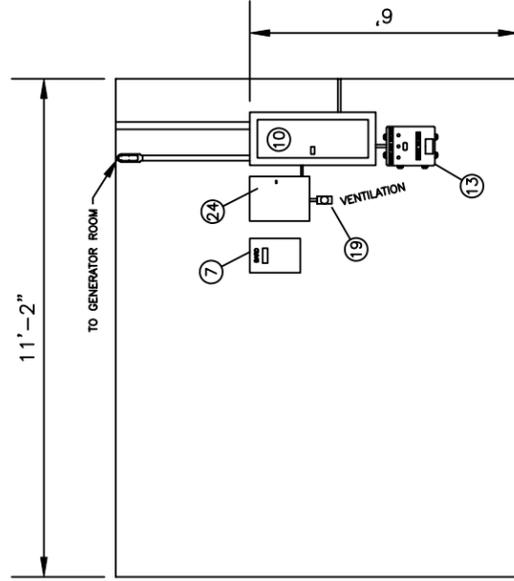
LIST OF MATERIAL

NOTES:

1. ALL DIMENSIONS ARE INSIDE DIMENSIONS.
2. ALL CONDUIT RUNS ARE APPROXIMATE AND MAY NOT REFLECT RUNS IN ACTUAL BUILDING.
3. INSTALL THE NATURAL GAS GEN SET IN THE AURORA BUILDING AND THE LP VAPOR GEN SET IN THE BROOKINGS NORTH BUILDING.



INTERIOR GENERATOR ROOM



INTERIOR EQUIPMENT ROOM

NO.	QTY.	DESCRIPTION
28.	1	ONAN 225 AMP, AUTOMATIC TRANSFER SWITCH #OTEC225
		ONAN 20 KW GENERATOR 20 GGMA, NATURAL GAS INSTALLED IN THE AURORA BUILDING AND LP VAPOR INSTALLED IN THE BROOKINGS NORTH BUILDING.
26.	1	20" MASTER GROUND BAR # GT114420, INTERIOR & EXTERIOR
25.	1	2 1/2" GENERATOR EXHAUST THIMBLE
24.	1	ALARM CABINET W/ TERMINAL STRIP & FOLLOWING ALARMS: HIGH-LOW TEMP, HUMIDITY, OPEN DOOR (2), SMOKE ,HEAT (GENERATOR ROOM) & POWER FAIL
23.	1	200 DEGREE HEAT DETECTOR. 3AU41 W/ 3KN55 RELAY
22.	1	SMOKE DETECTOR. 3KN56 W/ 3KN55 RELAY
21.	2	10# ABC FIRE EXTINGUISHER #41889
20.	1	36" BASEBOARD HEATER, # 3UG83,
19.	3	2E206 THERMOSTAT, (VENTILATION, BASEBOARD HEATER)
18.	1	30" INTAKE DAMPER W/ HOOD #3C234
17.	1	24" EXHAUST DAMPER W/ HOOD #3C315
16.	1	12" INTAKE DAMPER W/ WEATHERPROOF HOOD ##4C556 W/ #2C831 MOTOR
15.	2	12" EXHAUST FANS #1HLA2 W/ WEATHERPROOF HOOD
14.	2	100 W EXTERIOR LIGHT W/ VANDAL PROOF POLYCARBONATE LENS W/PE CELL #3GB98 W/ # 1NC57 BACK BOX
13.	1	ALANTIC SCIENTIFIC SURGE ARRESTER # 11214
12.	1	200 AMP METER SOCKET, MILBANK #U4801-XL
11.	1	200 AMP MAIN DISCONNECT,NEMA 3R, SQD # Q022200NRB W/ QBL22200 BREAKER
10.	1	120/240V., 200A. 1 PHASE DISTRIBUTION PANEL W/ 200A. MAIN BREAKER AND 40 POSITIONS, SQD#Q0140M200
9.	2	EXTERIOR GFI RECEPTACLE
8.	6	4', 2 BULB FLOURESCENT LIGHT FIXTURE
7.	1	MC3000A MASTER CONTROLLER
6.	2	WALL MOUNT AIR CONDITIONER, BARD 2 TON W5/KW HEAT #WA242-A05PXXXXJ
5.	10	110V. DUPLEX RECEPTACLES
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3.	2	LIGHT SWITCH SPEC. GRADE
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1.	1	3'X7' STEEL INSULATED DOOR AND FRAME W/BAKED ON ENAMEL PAINT (PLYCO SERIES 88) W/S.S. BALL BEARING HINGES W/NON REMOVEABLE PINS, SCHLAGE PASSAGE & MEDICO DEADBOLT, PICKPLATE & HYDRAULIC CLOSURE. BOTH DOOR LOCKS KEYED ALIKE .

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PROJECT
INTERSTATE TELCOM COOP
JOB NO.
1004-45
SITE NAME
BROOKINGS, SD



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Date: 7/21/10

Drawn By: DJO

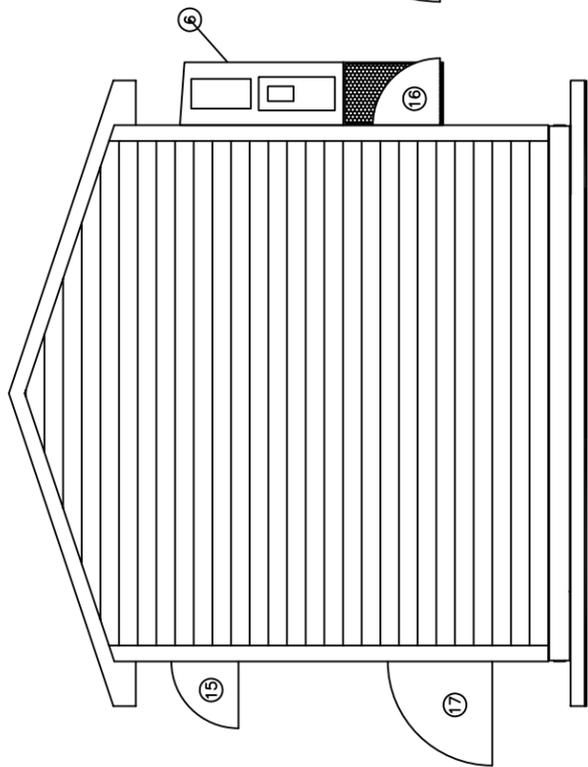
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Approved By:

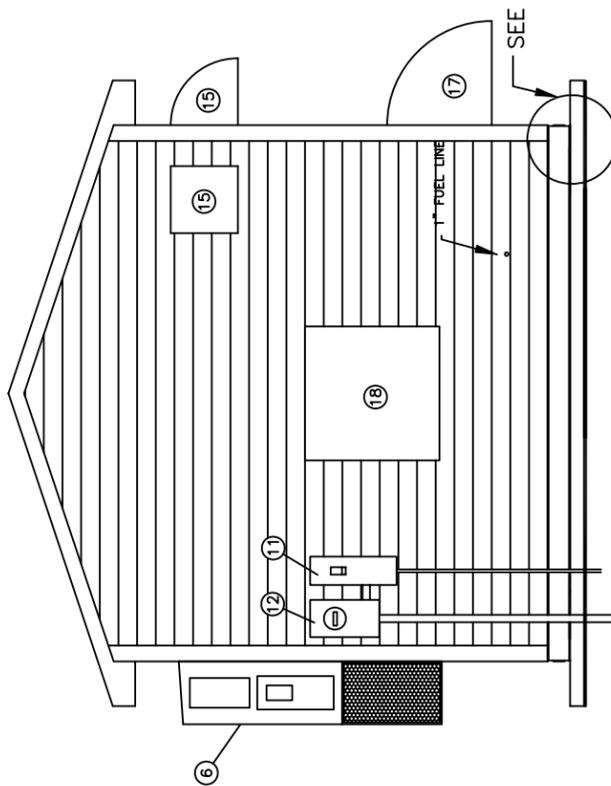
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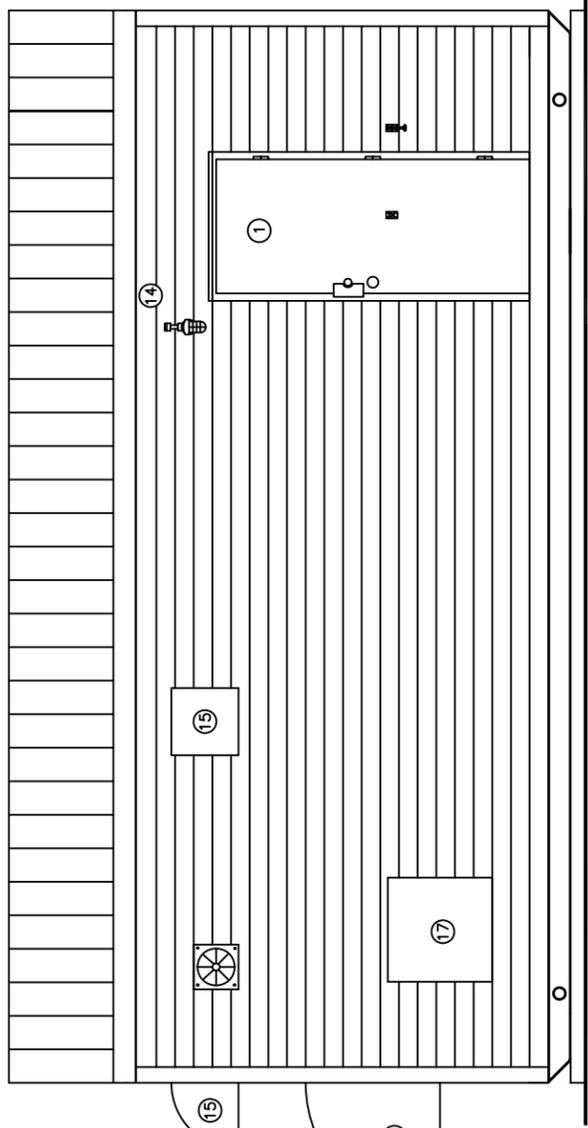
PAGE 4 OF 9



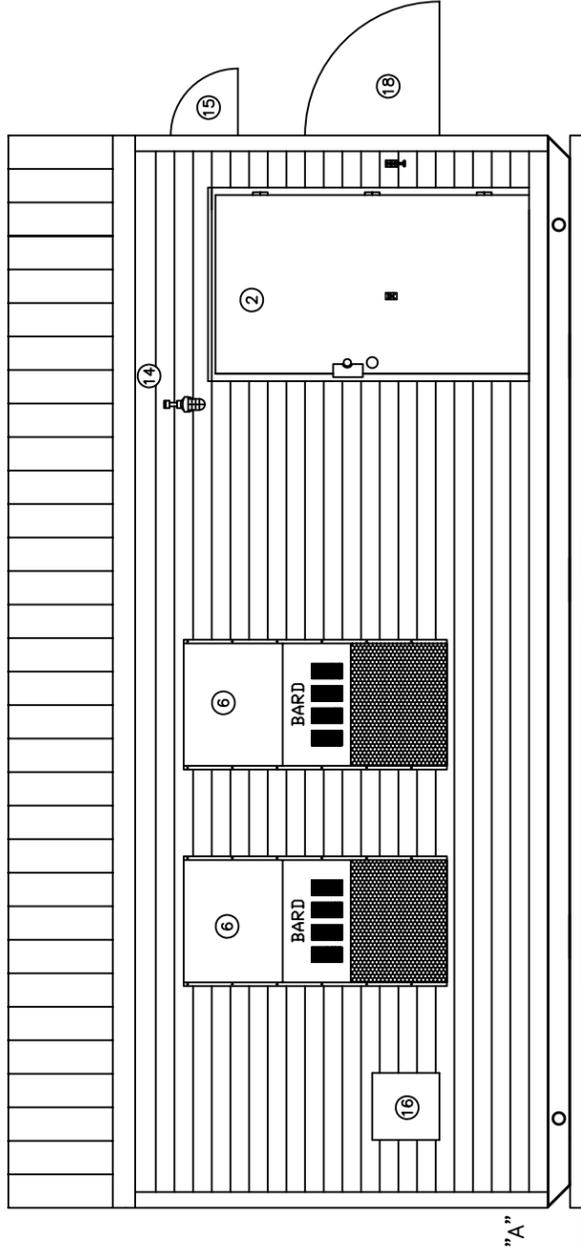
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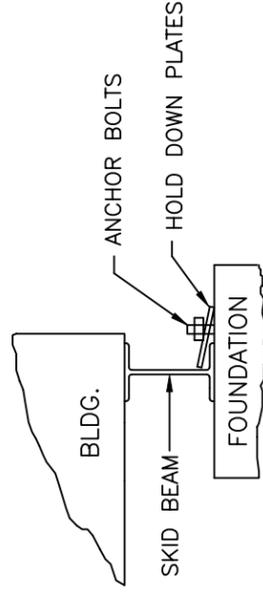
LEFT ELEVATION



FRONT ELEVATION



REAR ELEVATION



DETAIL "A"



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Date: 7/21/10	12'W. X 24'L. X 9'H. BLDG.
Drawn By: DUO	PROJECT NUMBER:
Approved By:	8/2/10
	Drawing Number: AGB8477
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	PAGE 5 OF 9

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PROJECT
 INTERSTATE TELCOM COOP
JOB NO.
 1004-45
SITE NAME
 BROOKINGS, SD



LOAD		TRIP	POLES	WIRE SIZE	A.I.R.
DESCRIPTION					
1	EQUIPMENT ROOM LIGHTS	20	1	12	10k
3	EQUIPMENT RM. OUTLETS	20	1	12	10k
5	EQUIPMENT RM. OUTLETS	20	1	12	10k
7	GENERATOR RM. OUTLETS	20	1	12	10k
9	GENERATOR ROOM LIGHTS	20	1	12	10k
11	EQUIPMENT ROOM VENTILATION	20	1	12	10k
13	SMOKE/HEAT DETECTOR	20	1	12	10k
15					
17					
19					
21					
23					
25					
27					
29					
31					
33					
35					
37					
39					
2	HVAC	30	2	10	10k
4	HVAC	30	2	10	10k
6	HVAC	30	2	10	10k
8	HVAC	30	2	10	10k
10	GENERATOR ROOM VENTILATION	20	1	12	10k
12	GFI	20	1	12	10k
14	POWER FAIL	30	2	10	10k
16	POWER FAIL	30	2	10	10k
18					
20					
22					
24					
26					
28					
30					
32					
34					
36					
38	SURGE ARRESTOR	60	2	8	10k
40	SURGE ARRESTOR	60	2	8	10k

SERVICE:	
DESIGNATION:	
LOCATION:	
WIRE SIZE	
POLES	
TRIP	
LOAD	
DESCRIPTION	

VOLTAGE: 240/120 PHASE: 1 WIRES: 4 CY. 60
 MAIN BREAKER: 200 AMP AIR 22k
 MLO MAIN BUS: 200 AMP
 FEEDS : TOP BOTTOM

MANUFACTURER: SQUARE D
 CATALOG NUMBERS: Q0140M200
 NO EQUAL: APPROVED EQUAL:
 MOUNTING: SURFACE FLUSH

PANEL CIRCUIT SCHEDULE

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PROJECT
 INTERSTATE TELCOM COOP
 JOB NO.
 1004-45
 SITE NAME
 BROOKINGS, SD

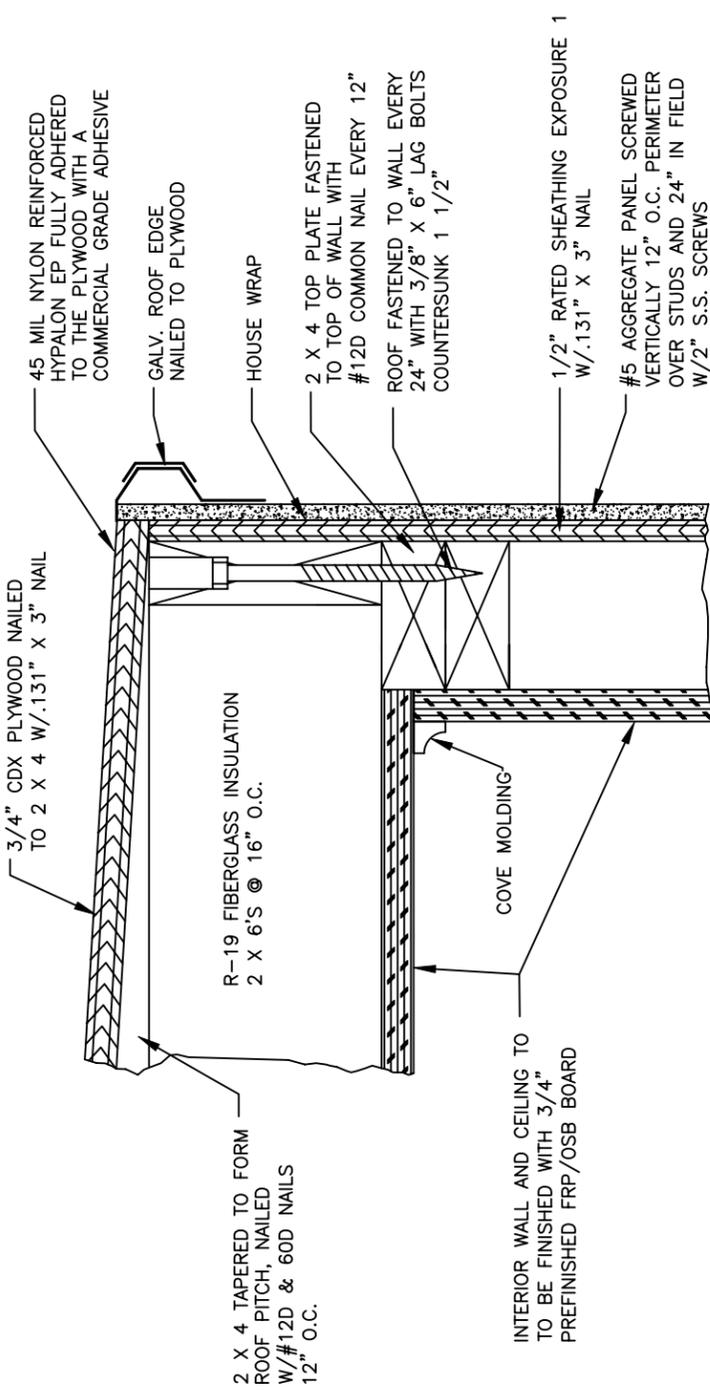


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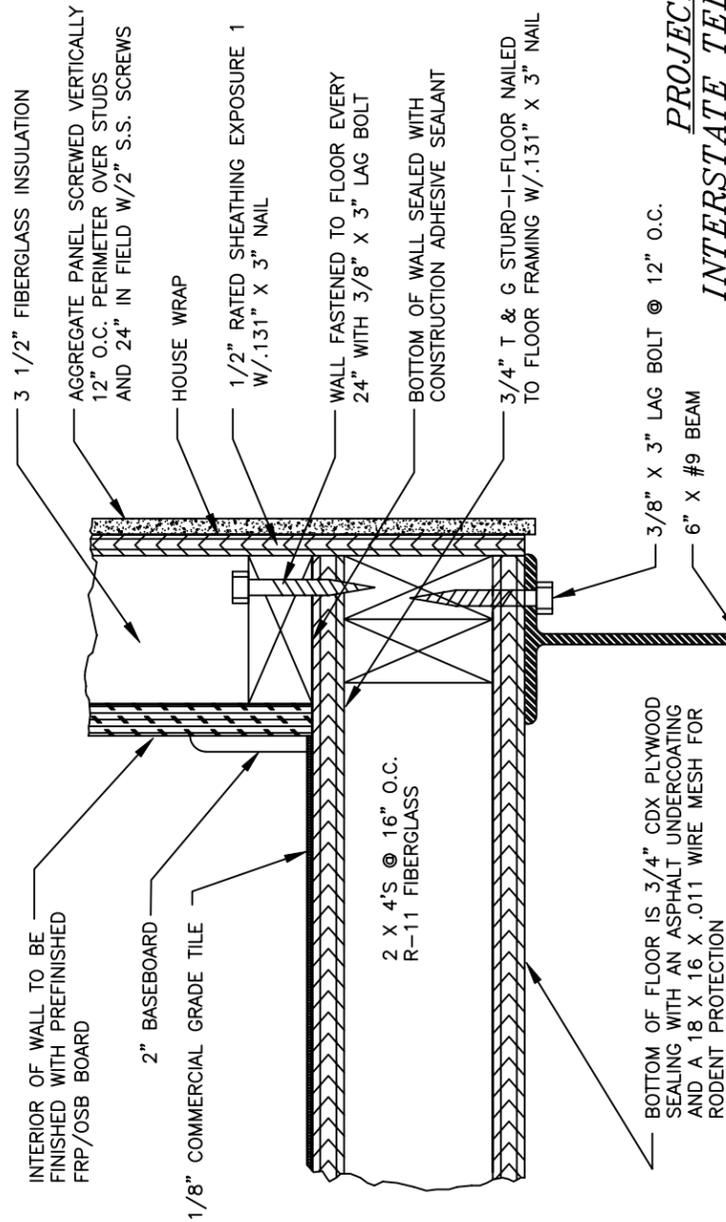
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 Date: 7/21/10
 Drawn By: DUO
 Approved By:

PROJECT NUMBER:
 Drawing Number:
 AGB8477

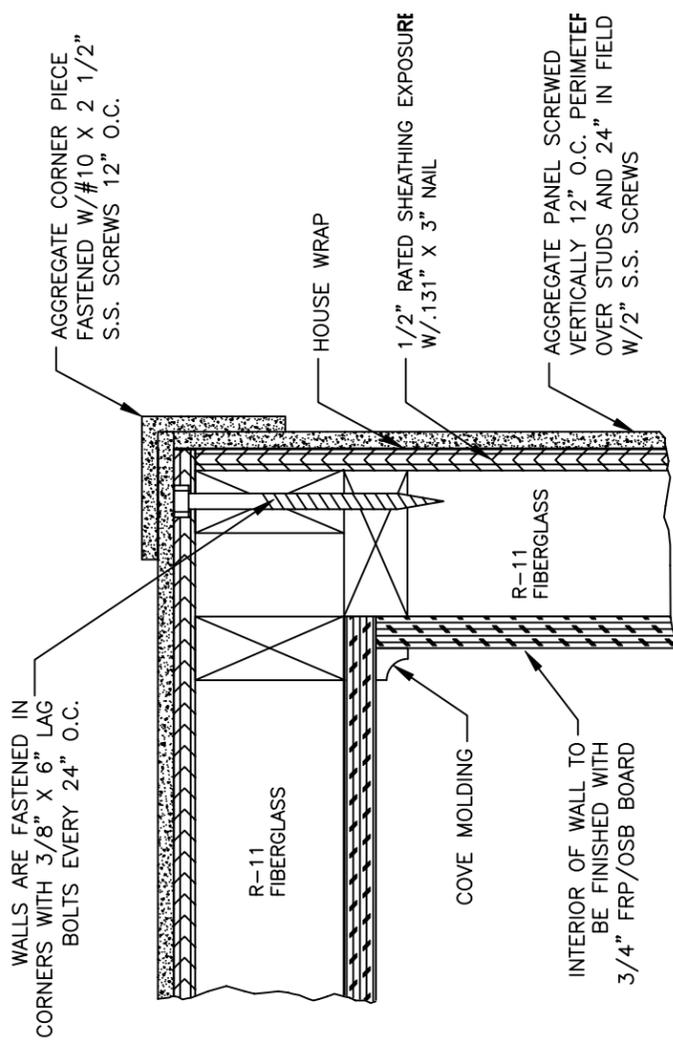
COMPUTER AIDED DRAWING AGB8477B
 PAGE 6 OF 9



WALL TO ROOF DETAIL



WALL TO FLOOR DETAIL



WALL CORNER DETAIL

NOTES:

1. ALL PLYWOOD SHALL BE NAILED EVERY 6" AROUND PERIMETER AND EVERY 12" IN FIELD.
2. HOUSE WRAP TO BE INSTALLED 1/8" BELOW SHEETING AND EXTEND TO TOP OF TOP PLATE. ALL SEAMS TO BE LAPPED 6" AND TAPED W/SEAM TAPE.
3. ALL SCREW HOLES THROUGH PANELS FILLED WITH POLYURETHANE CAULK PRIOR TO SCREW BEING INSTALLED.
4. ALL STRUCTURAL LUMBER SHALL BE SPF #1 OR #2.
5. ALL CDX, EXTERIOR SHEATHING & T&G GLUED TO STUDS WITH INER 45 FOAM GLUE TO ALL STUDS BEFORE NAILING.

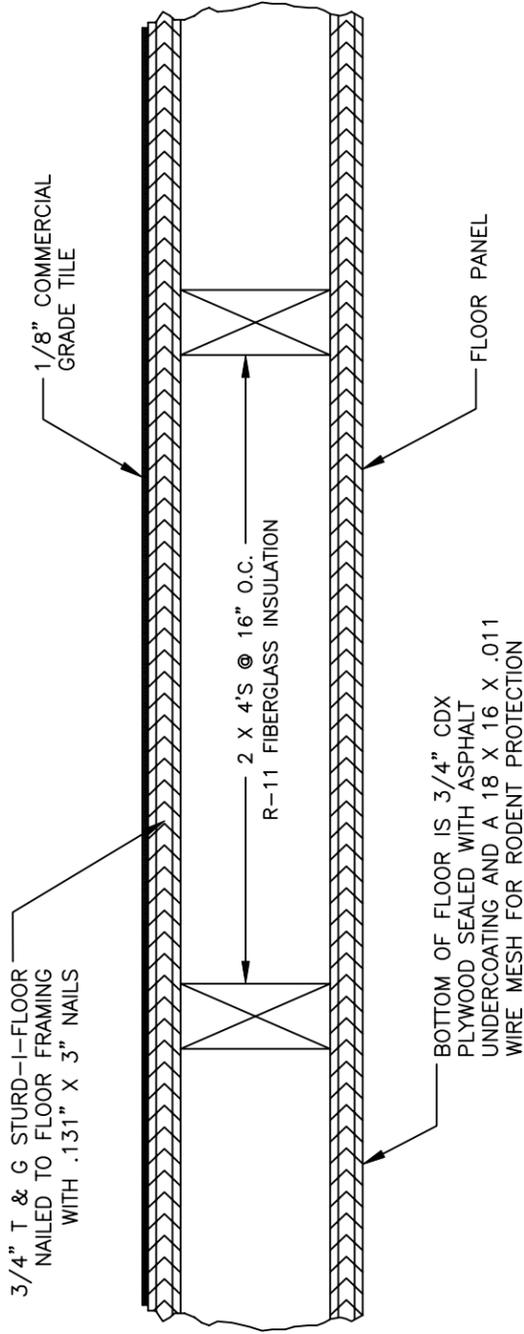
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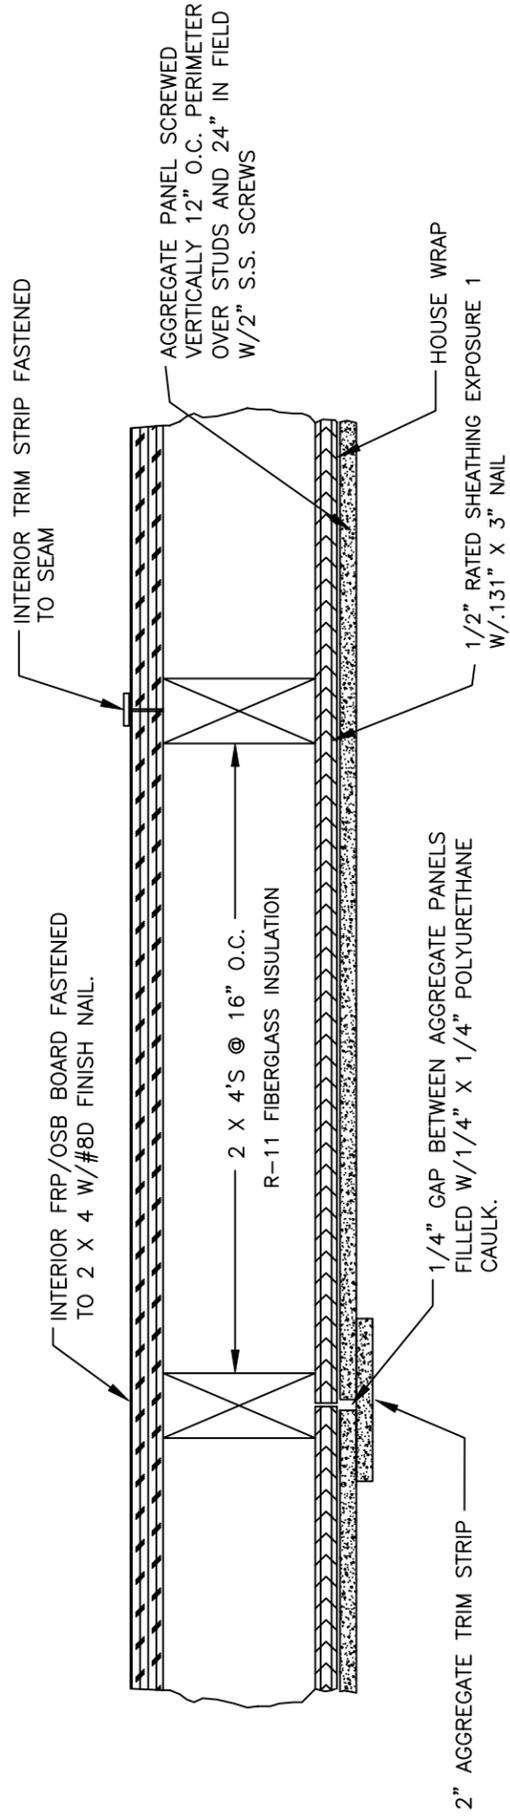
209 N. Court. P.O. Box 445, Elk Point, SD. 57025-0445
Phone: 605-356-2090, www.thermobond.com

Scale: NONE	Title: BUILDING CONSTRUCTION DETAILS
Date: 7/21/10	
Drawn By: DUO	PROJECT NUMBER:
Approved By:	Drawing Number: AGB8477
	COMPUTER AIDED DRAWING AGB8477C
	PAGE 7 OF 9

PROJECT
INTERSTATE TELCOM COOP
JOB NO.
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SITE NAME
BROOKINGS, SD



FLOOR DETAIL



WALL DETAIL

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PROJECT
INTERSTATE TELCOM COOP
JOB NO.
1004-45
SITE NAME
BROOKINGS, SD

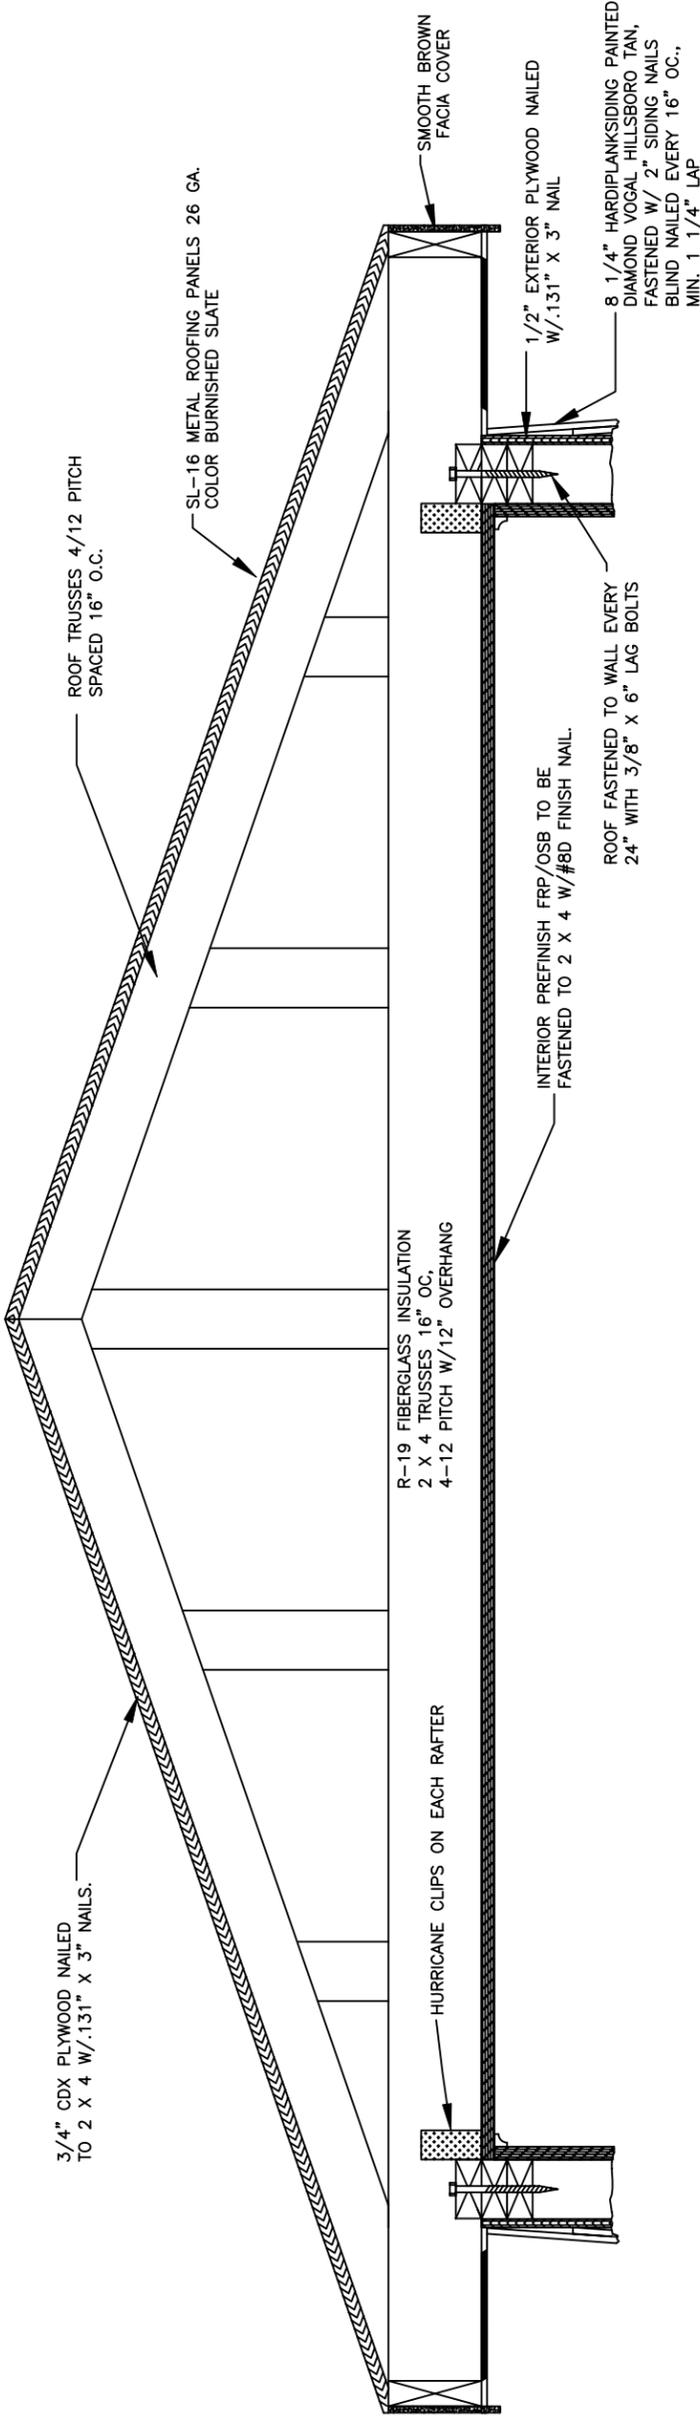
NOTES:

1. ALL PLYWOOD SHALL BE NAILED EVERY 6" AROUND PERIMETER AND EVERY 12" IN FIELD.
2. HOUSE WRAP TO BE INSTALLED 1/8" BELOW SHEETING AND EXTEND TO TOP OF TOP PLATE. ALL SEAMS TO BE LAPPED 6" AND TAPED W/SEAM TAPE.
3. ALL SCREW HOLES THROUGH PANELS FILLED WITH POLYURETHANE CAULK PRIOR TO SCREW BEING INSTALLED.
4. ALL STRUCTURAL LUMBER SHALL BE SPF #1 OR #2.
5. ALL CDX, EXTERIOR SHEATHING & T&G GLUED TO STUDS WITH INER 45 FOAM GLUE TO ALL STUDS BEFORE NAILING.

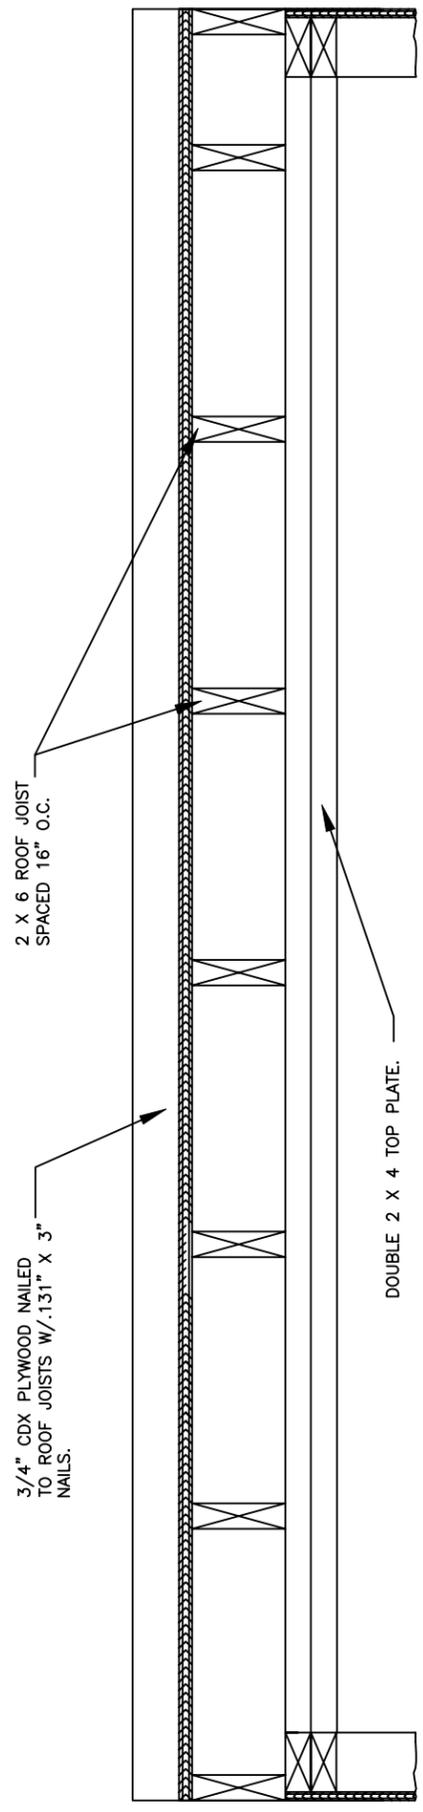


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Scale: NONE	Title: BUILDING CONSTRUCTION
Date: 7/21/10	DETAILS
Drawn By: DUO	PROJECT NUMBER:
Approved By:	Drawing Number: AGB8477
COMPUTER AIDED DRAWING AGB8477D	
PAGE 8 OF 9	



ROOF STRUCTURE END DETAIL



ROOF STRUCTURE SIDE DETAIL

NOTES:

1. ALL PLYWOOD SHALL BE NAILED EVERY 6" AROUND PERIMETER AND EVERY 12" IN FIELD.
2. HOUSE WRAP TO BE INSTALLED 1/8" BELOW SHEETING AND EXTEND TO TOP OF TOP PLATE. ALL SEAMS TO BE LAPPED 6" AND TAPED W/SEAM TAPE.
3. ALL SCREW HOLES THROUGH PANELS FILLED WITH POLYURETHANE CAULK PRIOR TO SCREW BEING INSTALLED.
4. ALL STRUCTURAL LUMBER SHALL BE SPF #1 OR #2.
5. ALL CDX, EXTERIOR SHEATHING & T&G GLUED TO STUDS WITH INER 45 FOAM GLUE TO ALL STUDS BEFORE NAILING.

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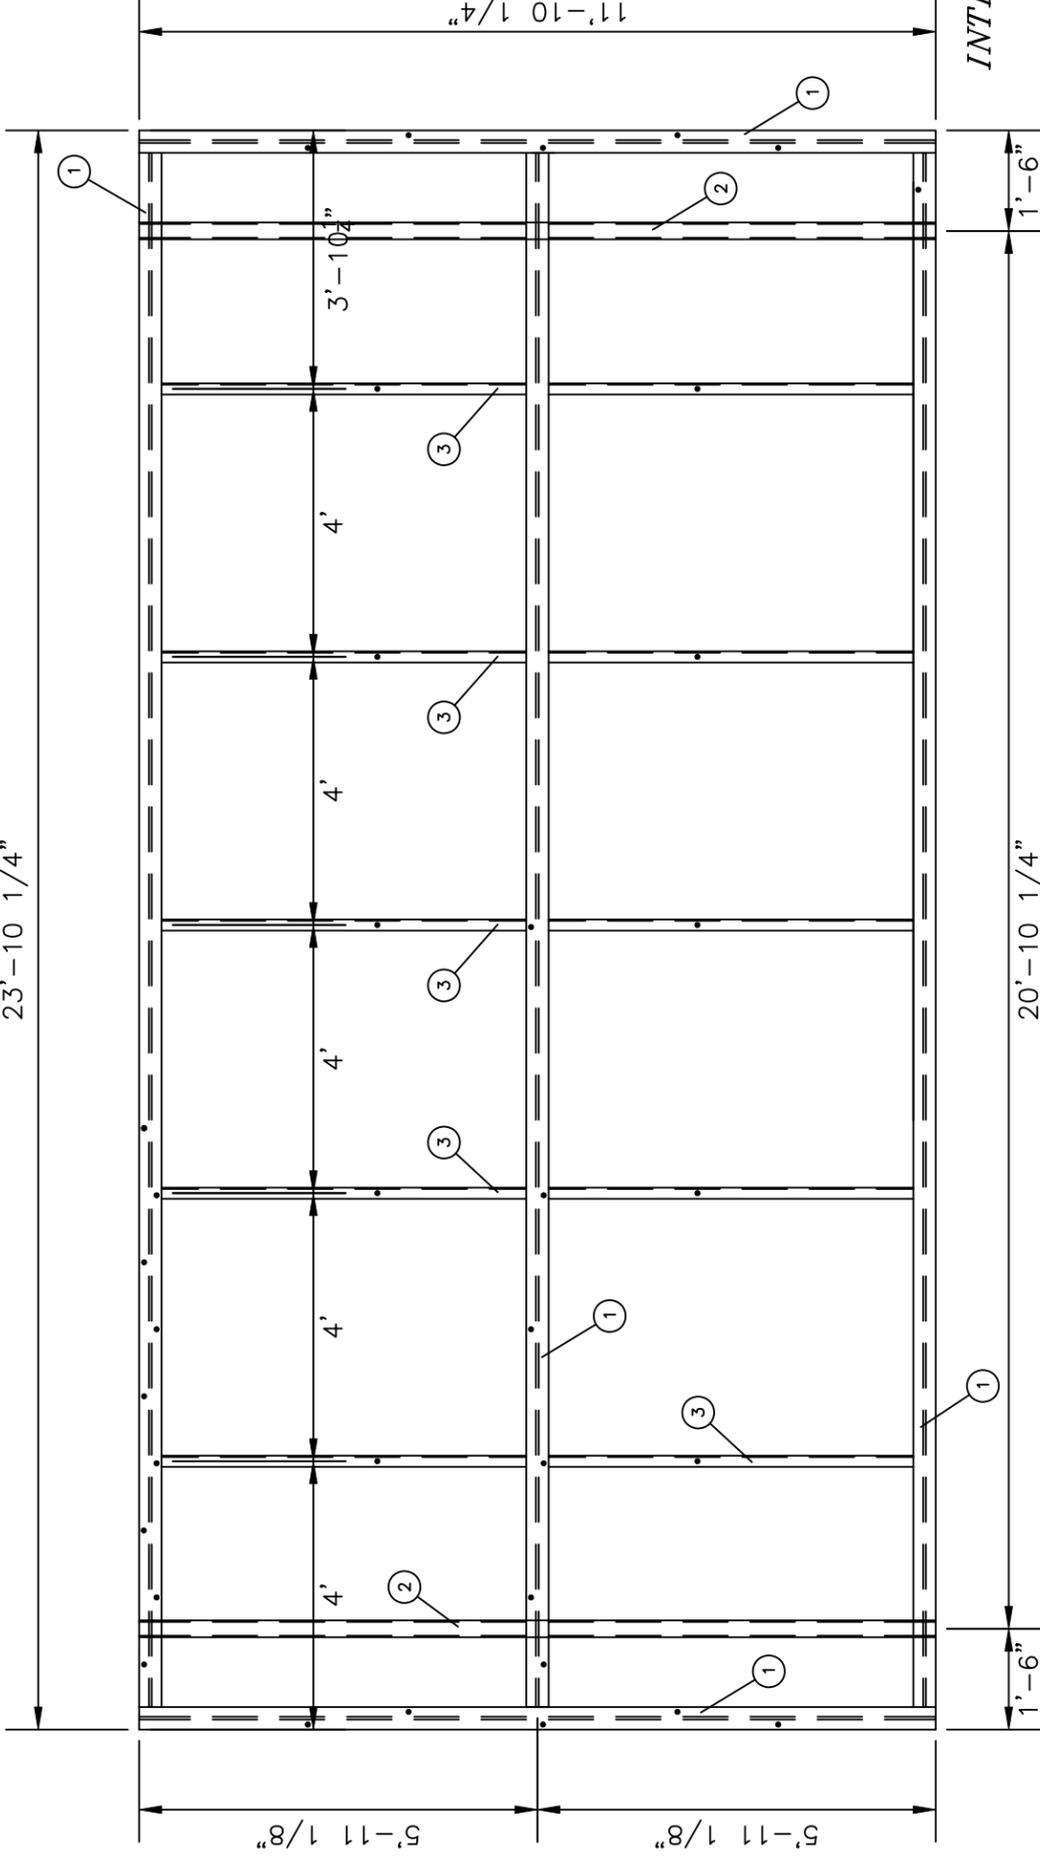
PROJECT
 INTERSTATE TELCOM COOP
 JOB NO.
 1004-45
 SITE NAME
 BROOKINGS, SD



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Scale: NONE	Title: BUILDING CONSTRUCTION
Date: 7/21/10	DETAILS
Drawn By: DUO	PROJECT NUMBER:
Approved By:	Drawing Number: AGB8477
	COMPUTER AIDED DRAWING AGB8477E
	PAGE 9 OF 9

23'-10 1/4"



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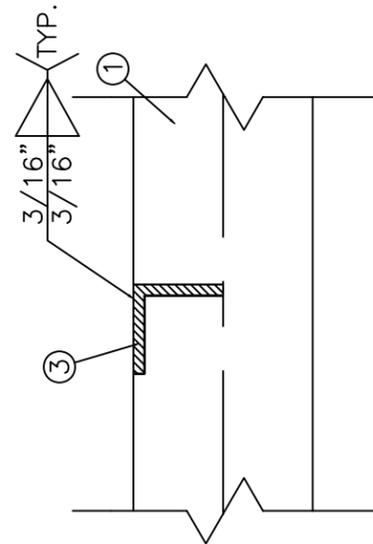
PROJECT
INTERSTATE TELCOM COOP
JOB NO.
1004-45
SITE NAME
BROOKINGS, SD

3/8" = 1' SCALE
 TOP VIEW

WELDED ASSEMBLY

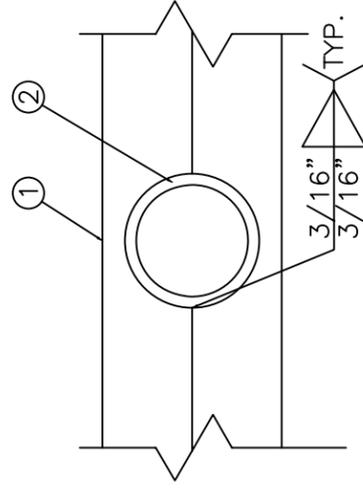
NOTES:
 1. FINISH: PAINTED WITH RUST PREVENTATIVE PAINT.

UNLESS OTHERWISE SPECIFIED ALL DIMENSIONS SHOWN ON THIS DRAWING SHALL HAVE THE FOLLOWING TOLERANCE:
 FRACTION ± 1/8"
 ANGLE ± 2°



3" = 1' SCALE

SECTION "A-A"



3" = 1' SCALE

SECTION "B-B"

		TOTAL BLACK STEEL WEIGHT 1136.1#	
NO.	QTY. DWG NO.	DESCRIPTION	WEIGHT
3.	6	15B7002 ANGLE, SUPPORT (2 X 2 X 1/4)	173.1#
2.	2	PIPE SUPPORT (3" NOM. SCH 40)	179.7#
1.	5	15B6020 BEAM SUPPORT (W6 X 9#) GRADE 50	839.4#

LIST OF MATERIAL

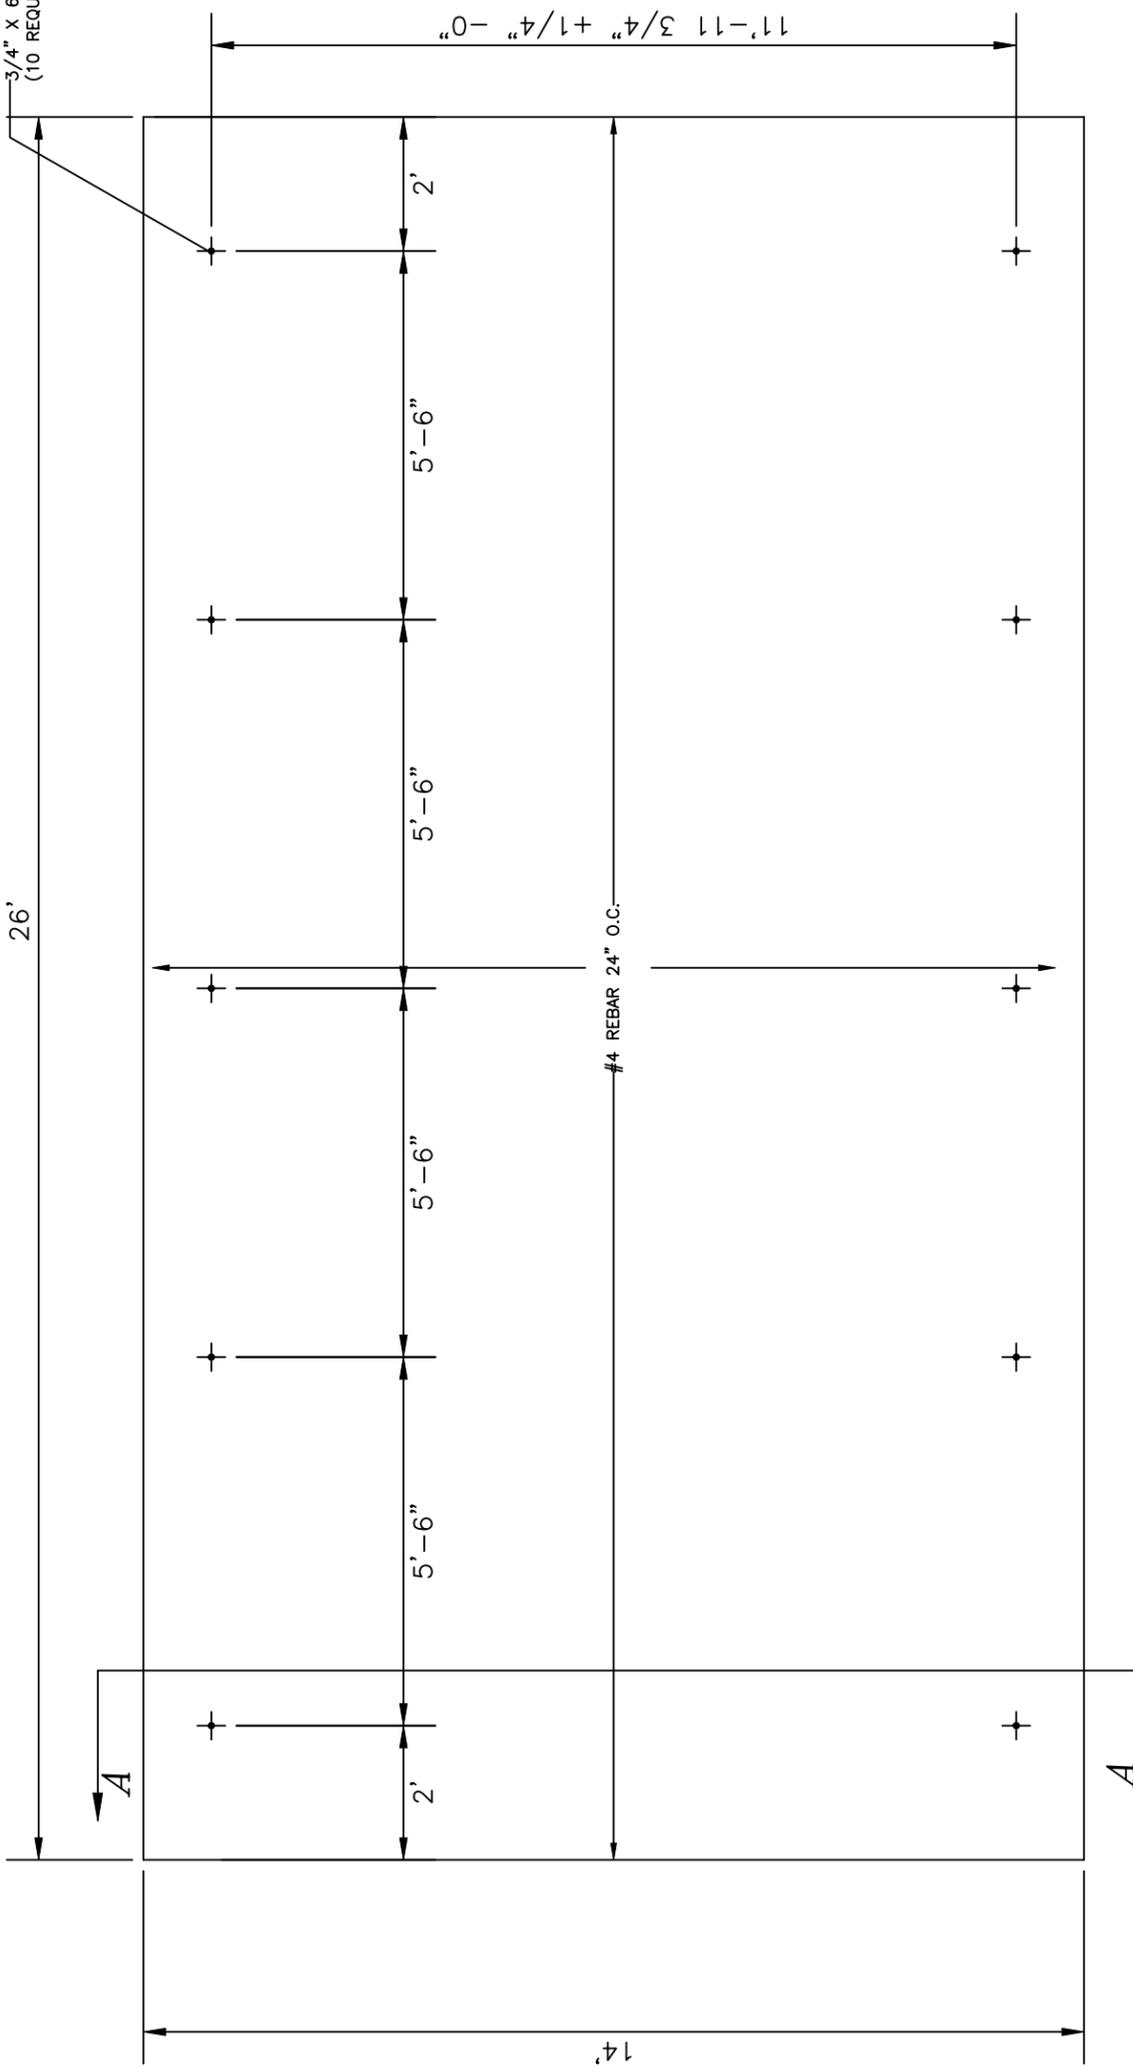


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 Phone: 605-368-2090, www.thermobond.com

Scale: AS NOTED	Title: BOX BUILDING SKID ASSEMBLY
Date: 7/21/10	FOR 12' X 24' BUILDING
Drawn By: DUO	PROJECT NUMBER:
Approved By:	Drawing Number: 15B1224
	PAGE 1 OF 1

COMPUTER AIDED DRAWING 15B1224

3/4" X 6" ANCHOR BOLTS
(10 REQUIRED)



11'-11 3/4" + 1/4" - 0"

#4 REBAR 24" O.C.

PLAN VIEW

NOTES:

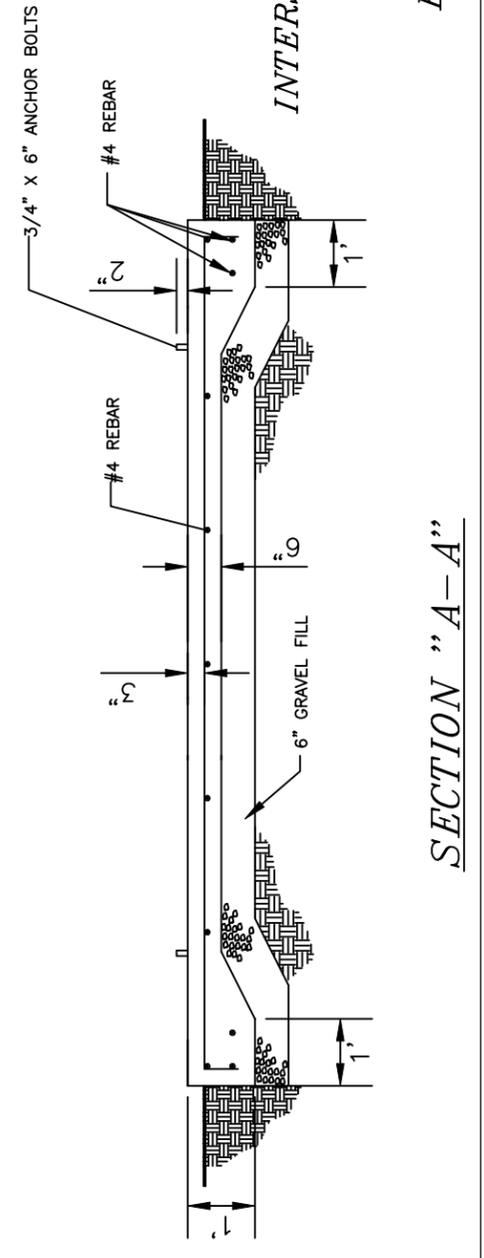
1. CONCRETE SHALL ATTAIN A MINIMUM ULTIMATE COMPRESSION STRENGTH OF 4000 PSI WITHIN 28 DAYS.
2. ALL WIRE MESH TO HAVE A MINIMUM OF 2" CONCRETE COVER.

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Scale: 3/8" = 1'	Title: SLAB BUILDING FOUNDATION
Date: 7/21/10	FOR 12' X 24' BUILDING
Drawn By: DUO	PROJECT NUMBER:
Approved By:	Drawing Number: S15B1224
	COMPUTER AIDED DRAWING S15B1224
	PAGE 1 OF 1



SECTION "A-A"

PROJECT
INTERSTATE TELCOM COOP
JOB NO.
1004-45
SITE NAME
BROOKINGS, SD

Typical Construction Equipment on Site During Installation.*



Photo 1: Typical cable plowing operation.



Photo 2: Typical directional boring equipment.



Photo 3: Paired conduit with fiber optic cable installed in one.



Photo 4: Directional boring equipment.



Photo 5: Tornado fiber optic blowing machine.



Photo 6: Rock saw



Photo 7: Off-set plow.



Photo 8: Rock saw.

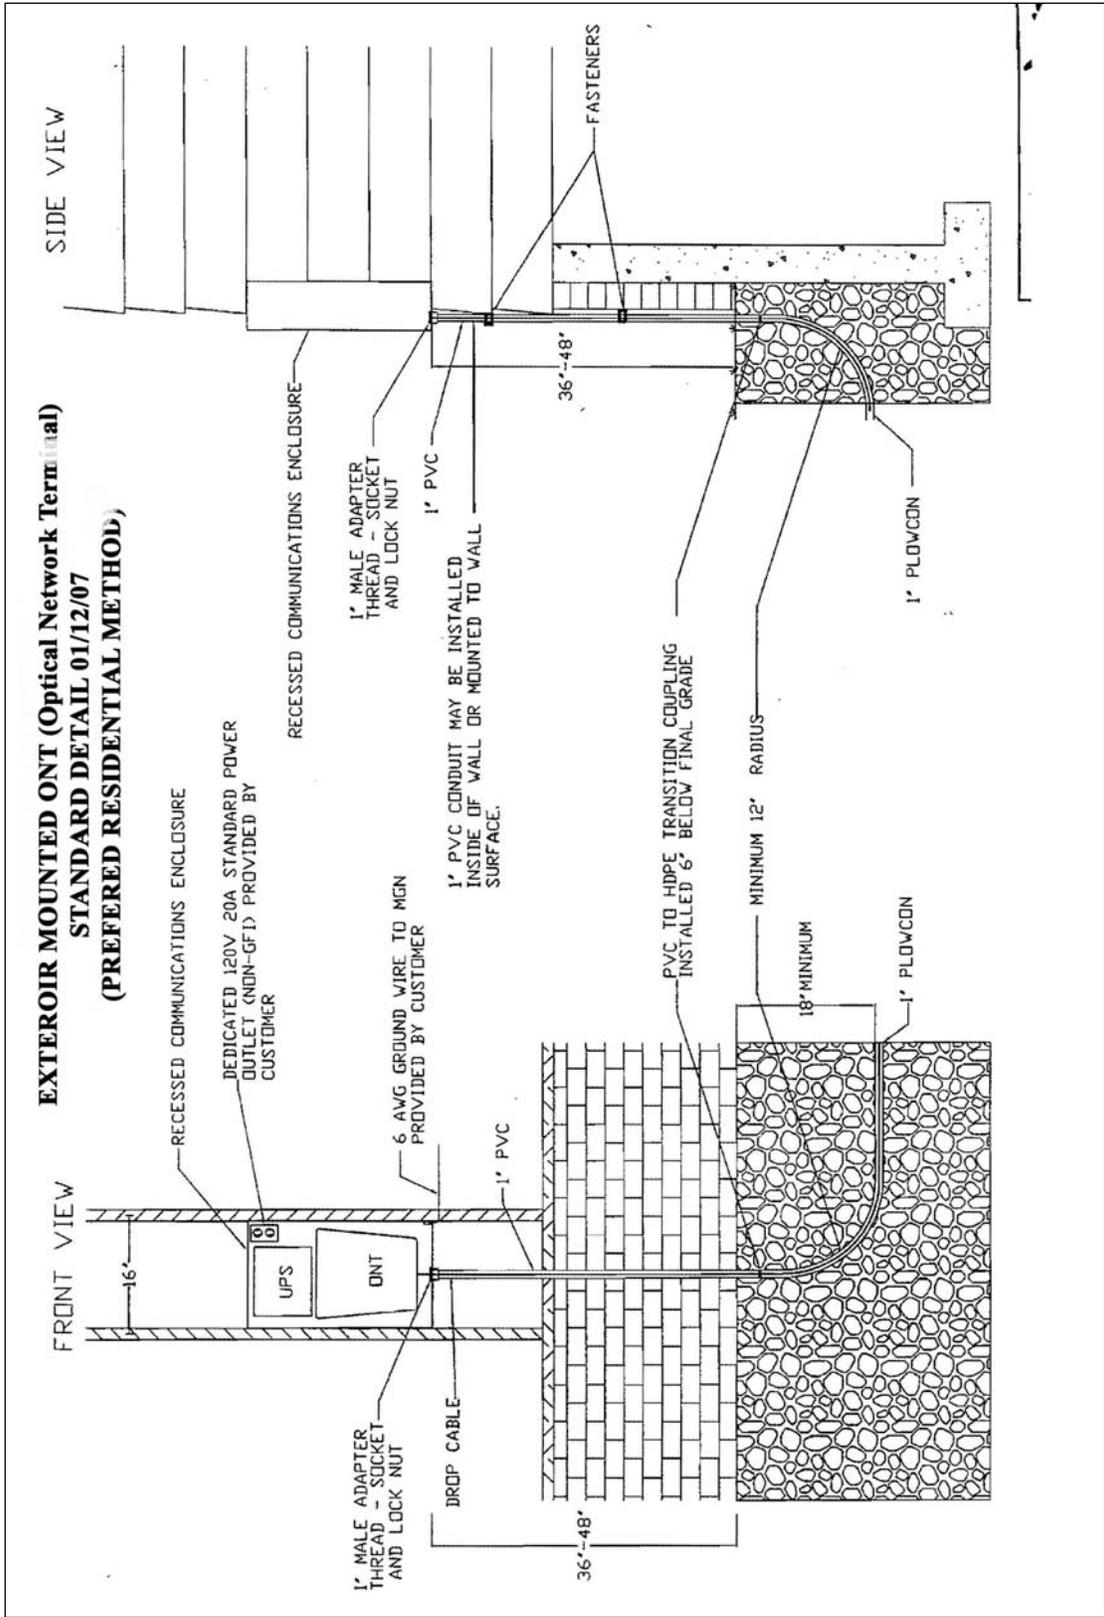


Photo 9: Single line cable plow operation.



Photo 10: Conduit installation under bridge.

*Although the above equipment is typical, the actual machines used may vary depending on the various contractors hired for the installation.



Typical exterior mounted optical network terminal (ONT) schematic.